



July 20, 2009

Mr. Thomas Teckman  
PO Box 9  
Goodman, WI 54125-0009

RE: **Final Closure**

**Commerce # 54125-9999-10-A** DNR BRRTS # 03-38-443242  
American Graphics, Inc. (Former), 610 Main Street, Goodman

Dear Mr. Teckman:

The Wisconsin Department of Commerce (Commerce) has reviewed the file for the site referenced above. Commerce has determined that this site does not pose a significant threat to human health or the environment. This case is now listed as "closed" on the Commerce database. No further investigation or remedial action is necessary.

It is in your best interest to keep all documentation related to the environmental activities at your site. If residual petroleum contamination is encountered in the future, it must be managed in accordance with all applicable state and federal regulations. If it is determined that any remaining petroleum contamination poses a threat, the case may be reopened and further investigation or remediation may be required.

Thank you for your efforts to protect Wisconsin's environment. If you have any questions, please contact me in writing at the letterhead address or by telephone at (920) 303-5410.

Sincerely,

Beth A. Erdman  
Senior Hydrogeologist  
Site Review Section

Enclosure: Commerce Memorandum



ENVIRONMENTAL & REGULATORY SERVICES DIVISION  
BUREAU OF PECFA  
375 City Center, Suite I  
Oshkosh, Wisconsin 54901-1805  
TTY: Contact Through Relay  
Fax: (920) 424-0217  
Jim Doyle, Governor  
Richard J. Leinenkugel, Secretary

## MEMORANDUM





**DATE:** July 16, 2009  
**TO:** File  
**FROM:** Beth Erdman, Site Review Section  
**SUBJECT:** Commerce # 54125-9999-10-A DNR BRRTS # 03-38-443242  
American Graphics Inc (Former), 610 Main Street, Goodman

This site was transferred to Commerce on December 18, 2008. Commerce reviewed the file and found the following:

- The Commerce and BRRTS numbers are for a fuel oil underground storage tank (UST).
- During the removal of the fuel oil UST, 2.5 cubic yards of soil was removed and stockpiled onsite.
- The soil sample collected from the soil pile contained soil contaminant concentrations exceeding NR 720 residual contaminant levels (RCLs).
- The soil samples collected from push probes directly surrounding the former fuel oil UST did not contain diesel range organic compounds (DRO) exceeding NR 720 RCLs.
- Soil samples were also collected and analyzed for polycyclic aromatic hydrocarbons (PAHs). However, the laboratory detection limits were too high to accurately determine whether concentrations exceeded groundwater or direct contact pathways.
- A separate Brownsfield cleanup was conducted at the site to address the contamination from three solvent USTs removed from the site.
- The fuel oil tank was located within the solvent plume.
- Many monitoring wells and piezometers were installed as part of the solvent cleanup.
- Monitoring wells MW-1 through MW-3, MW-105 and piezometers PZ-101 and 102 were located around the former fuel oil UST.
- None of the groundwater samples collected from the above wells contained petroleum analytes exceeding the laboratory limits of detection.
- On July 16, 2009 Commerce visited the property and determined no excavated soil remains.

Based on the above, Commerce believes that site closure is warranted with regard to the former fuel oil UST.

6TH STREET

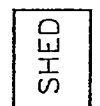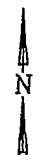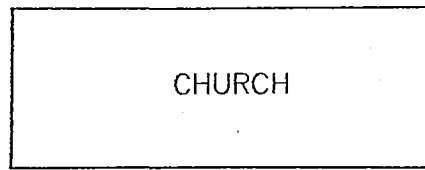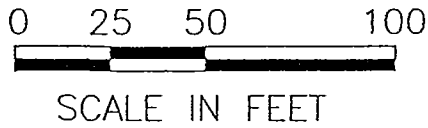

UST







APPROXIMATE PROPERTY BOUNDARY





SLOPE

SLOPE

MAIN STREET

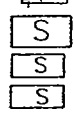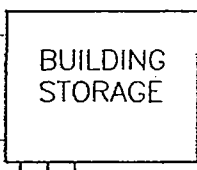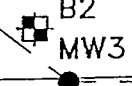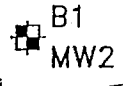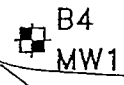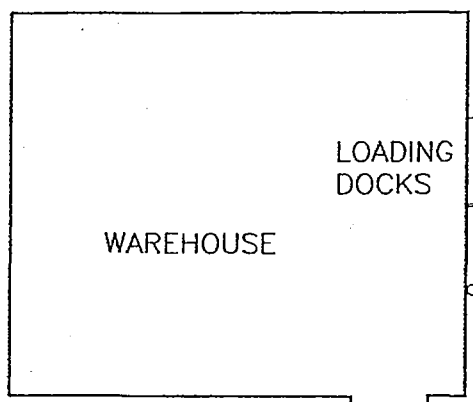

PRESS

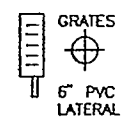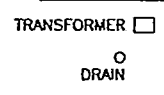


**LEGEND**

- B3 EXISTING SOIL BORING
- B1 MW2 EXISTING MONITORING WELL
- PROPOSED HYDRAULIC PROBE
- S SOLVENT TANKS
- H HEATING FUEL TANKS
- OVERHEAD UTILITIES

7TH STREET

SOURCE NOTE:  
THIS DRAWING WAS DEVELOPED FROM  
MAP BY REMEDIAL ENGINEERING, INC.  
DATED 1/10/94, PROJECT NO #0188R.

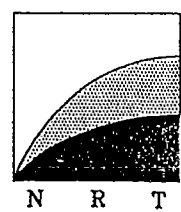

Natural  
Resource  
Technology

**SITE PLAN**

AMERICAN GRAPHICS, INC.  
610 MAIN STREET  
GOODMAN, WISCONSIN

DRAWN BY: TAS

APPROVED BY: TEM

DATE: 9/15/95

PROJECT NO. 89510

DRAWING NO. 89510-A1

FIGURE NO. 2

HIGH SCHOOL

MAIN ST

SHOP

OFFICE

THOMAS MACHINE

NEW ADD

50'


20'

UNDER GROUND TANKS

N

W

(S)

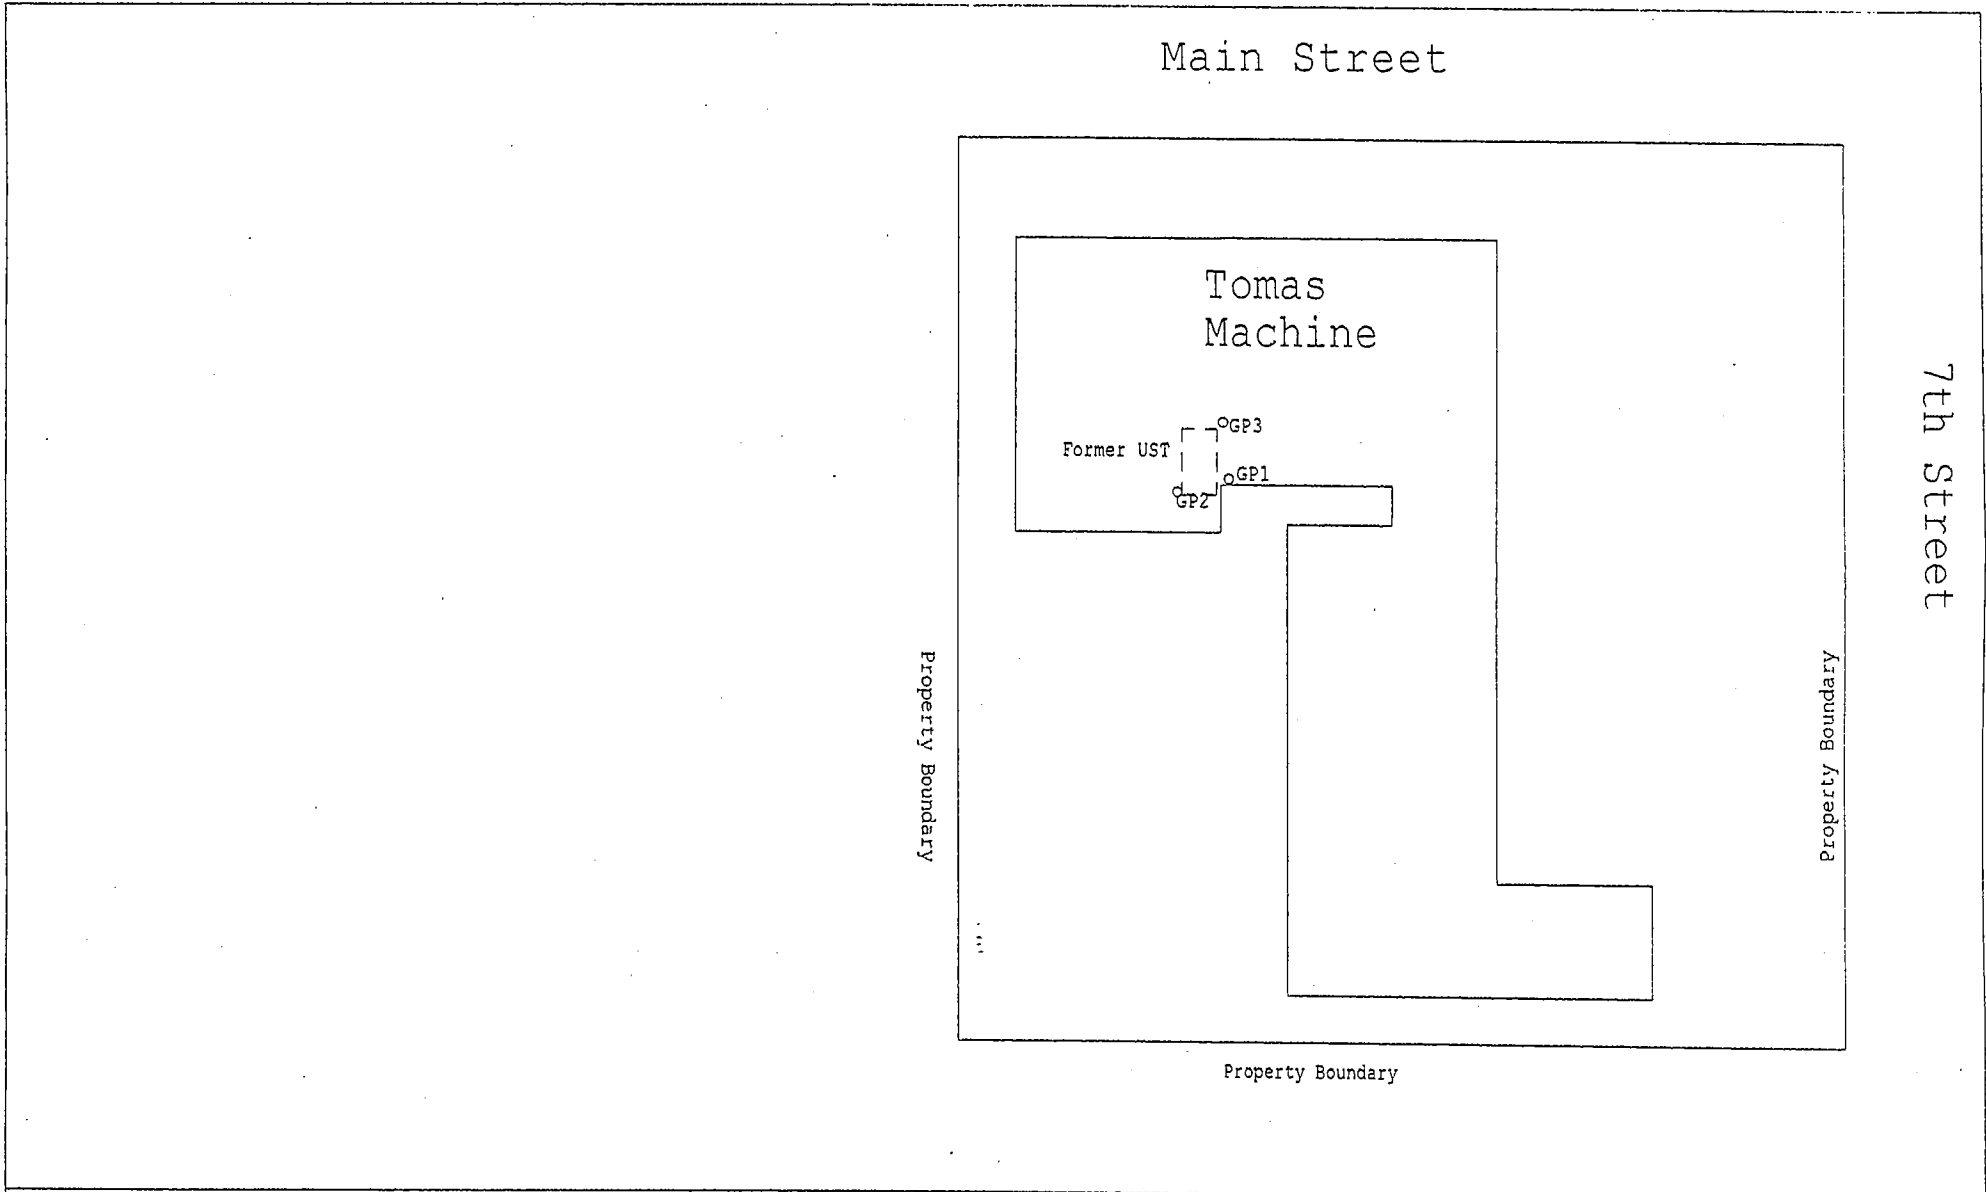

Environmental  
Assessments, Inc.  
P.O. Box 9127  
Appleton, WI 54911  
(920)749-9746

Title:  
Site Map Showing  
Sampling Locations

Figure #1

Scale: 1" = 40'


Drawn By: VAF

**LEGEND**


- PZ-103 PIEZOMETER
- MW-103 MONITORING WELL
- SB-101 SOIL BORING
- SW-101 STAFF GAUGE
- PRIVATE POTABLE WELL (APPROXIMATE)
- WATER VALVE
- HYDRANT
- POWER POLE
- LIGHT POLE
- OVERHEAD ELECTRIC
- SANITARY SEWER & MANHOLE
- CULVERT
- MSL MEAN SEA LEVEL

**NOTES:**

- MW-1, MW-2, AND MW-3 CONSTRUCTED BY REI IN 1993.
- MW-101 THROUGH MW-109 AND PZ-101 THROUGH PZ-104 INSTALLED BY NRT IN 1996.
- MW-110, MW-111, MW-112, AND PZ-105 INSTALLED BY NRT IN 1997.
- OW-1, OW-2, AND OW-3 CONSTRUCTION UNKNOWN.

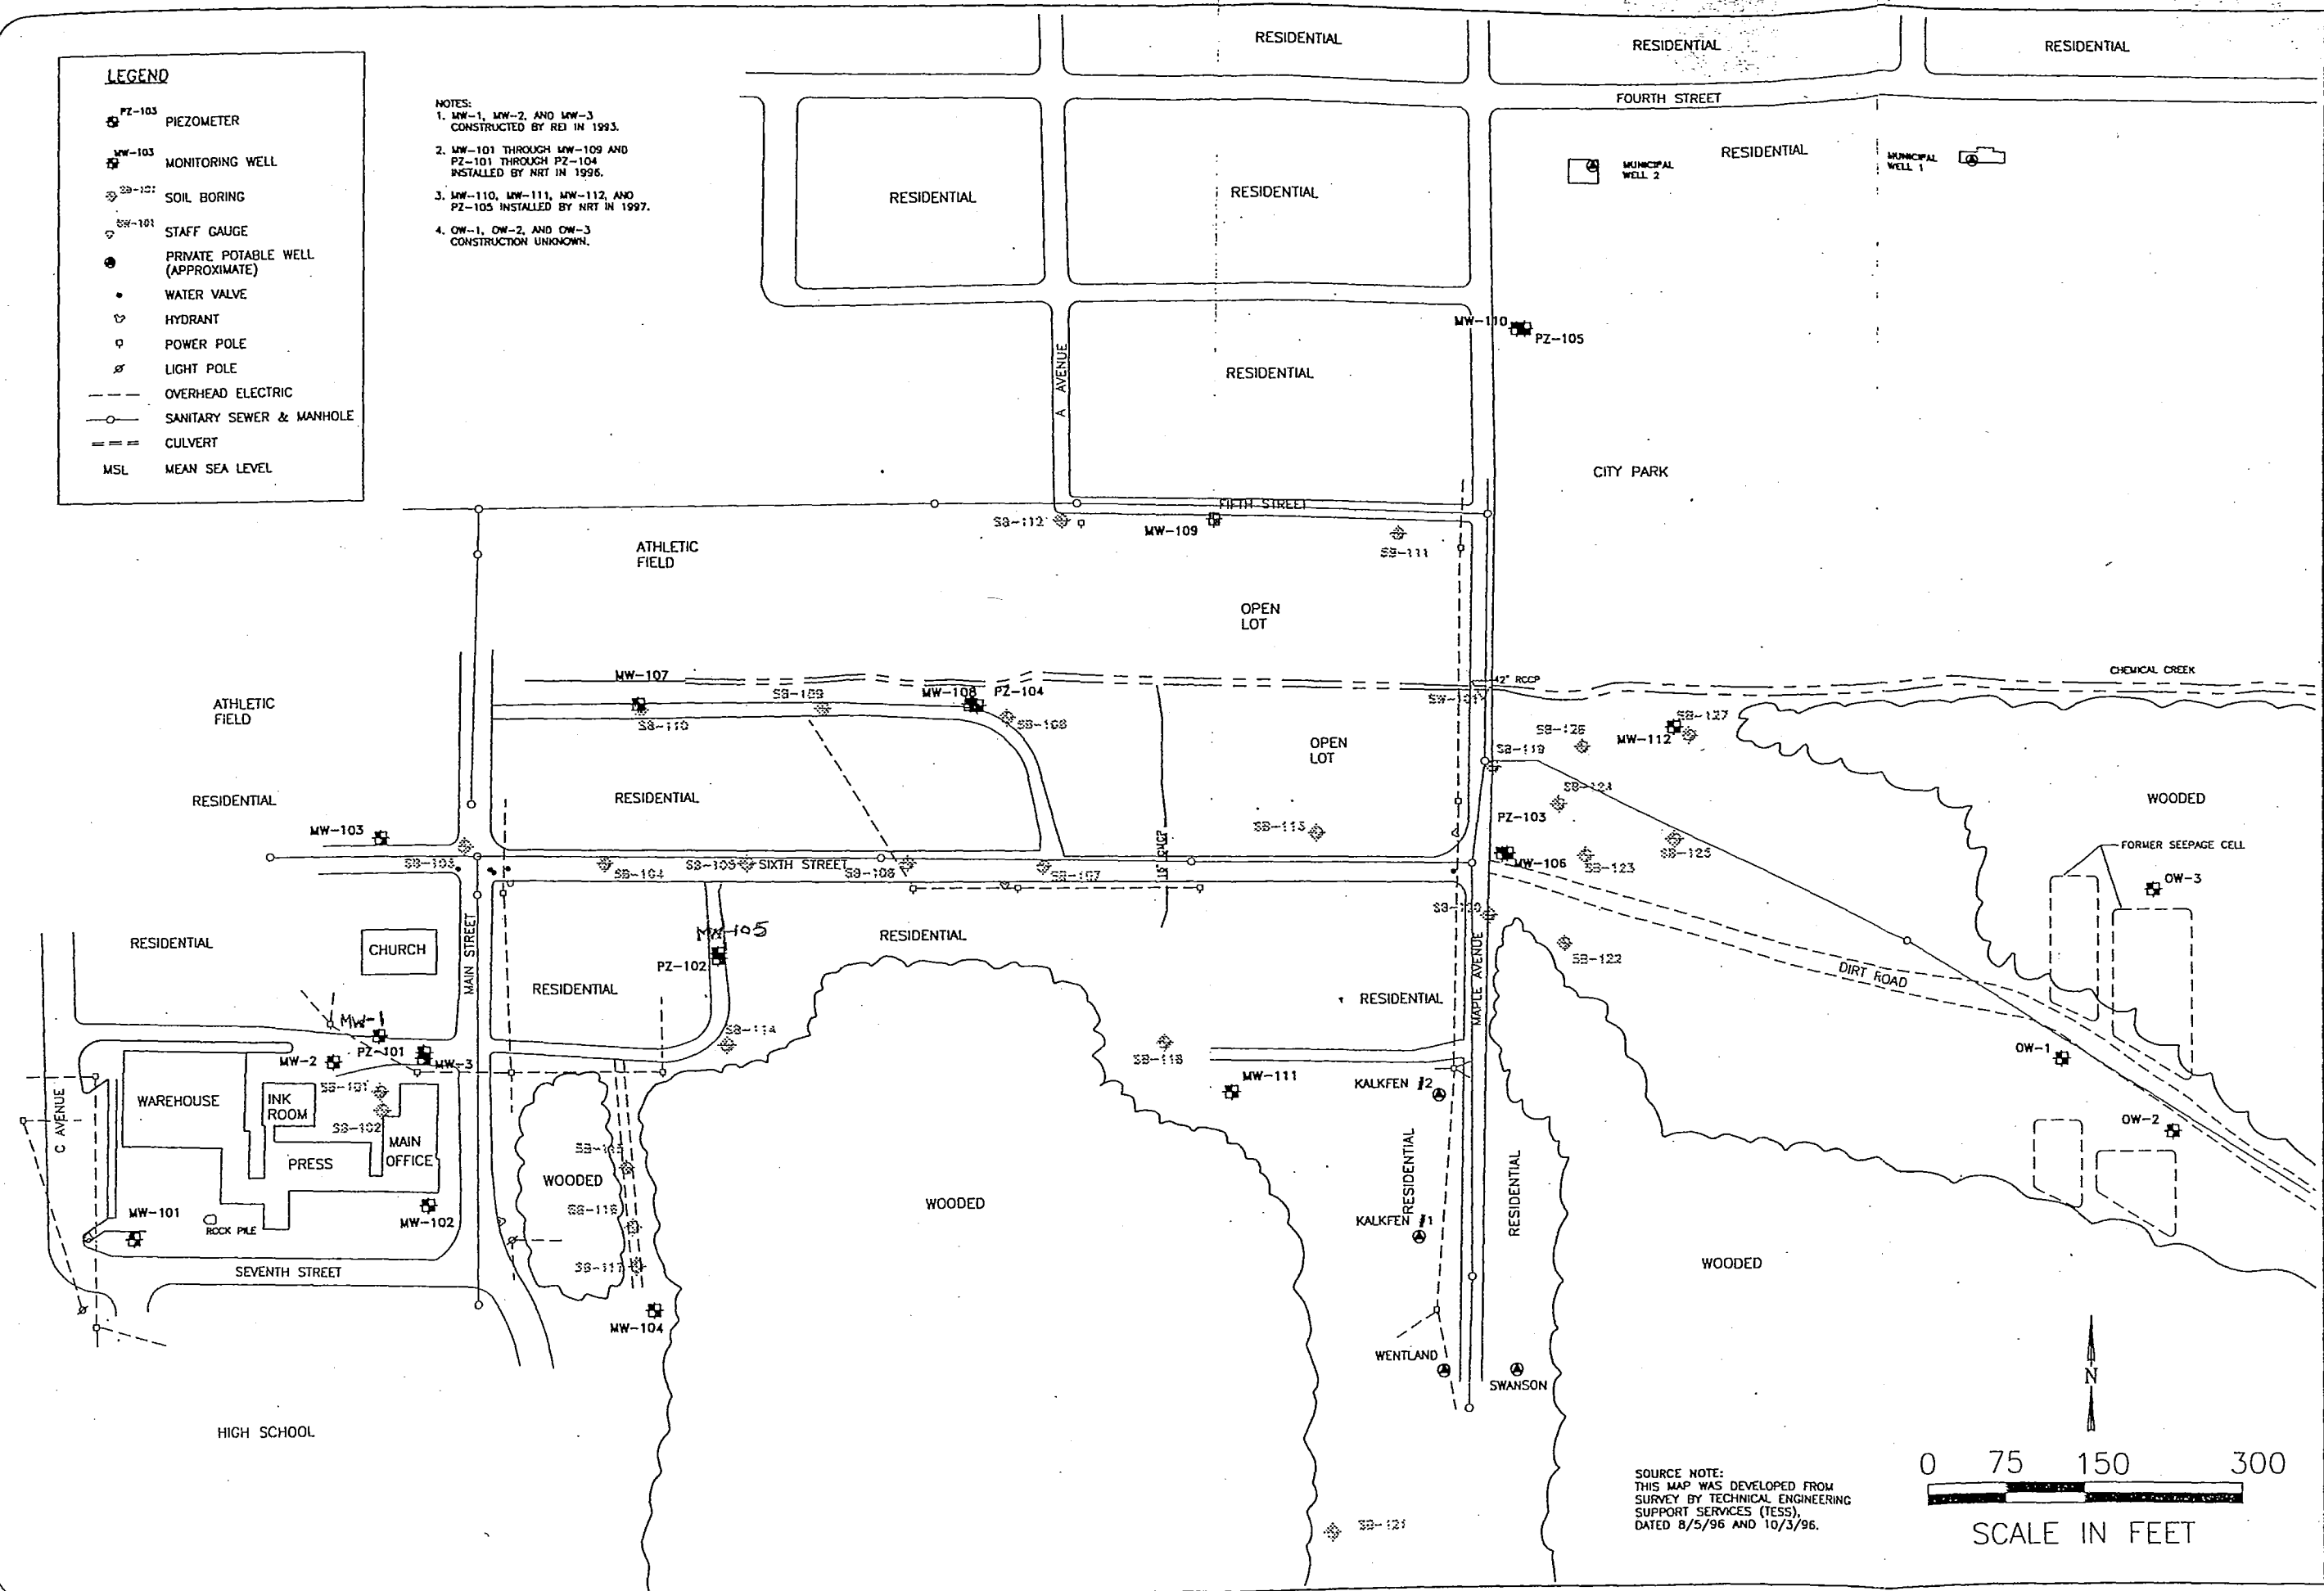


**SOURCE NOTE:**  
 THIS MAP WAS DEVELOPED FROM SURVEY BY TECHNICAL ENGINEERING SUPPORT SERVICES (TESS), DATED 8/5/96 AND 10/3/96.

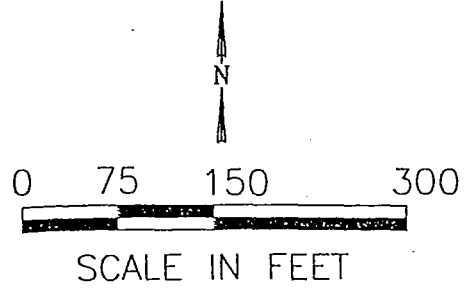

DRAWN BY: TAS  
 CHECKED BY: BSK  
 APPROVED BY: TEM

DATE: 12/16/97  
 DATE: 02/03/98  
 DATE: 2-3-98

**INVESTIGATION AREA LAYOUT**  
 ADDITIONAL SITE INVESTIGATION  
 FORMER AMERICAN GRAPHICS, INC. FACILITY  
 610 MAIN STREET

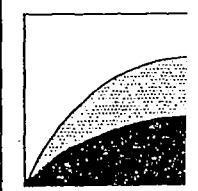

**Natural Resource Technology**

PROJECT NO 1135/7  
 DRAWING NO 1135-B21  
 FIGURE NO. 1

Table 1 - Soil Analytical Results

Soil Sample Location	GP1	GP2	GP3	Soil Pile	RCLs
Date	10/1/2001	10/1/2001	10/1/2001	10/1/2001	
Depth	6'-8'	4'-6'	6'-8'	NA	
DRO (mg/kg)	<10	<10	37	1400	250
PAH(s) (ug/kg)					
Acenaphthene	<13	<13	<13	<13	
Acenaphthylene	<10	<10	<10	<10	
Anthracene	<11	<11	<11	680	
Benzo(a)anthracene	<10	<10	<10	44	
Benzo(a)pyrene	<17	<17	<17	<17	
Benzo(b)flouranthene	<24	<24	<24	<24	
Benzo(g,h,i)perylene	<10	<10	<10	<10	
Benzo(k)flouranthene	<37	<37	<37	<37	
Chrysene	<10	<10	<10	87	
Dibenzo(a,h)anthracene	<10	<10	<10	<10	
Flouranthene	<10	<10	<10	120	
Flourene	<11	<11	<11	690	
Indeno(1,2,3-cd)pyrene	<13	<13	<13	<13	
1-Methyl naphthalene	<10	<10	<10	530	
2-Methyl naphthalene	<17	<17	<17	<17	
Naphthalene	<10	<10	<10	<10	
Phenanthrene	<12	<12	13 J	1400	
Pyrene	<13	<13	<13	1200	

J - Analyte detected between LOD and LOQ

**Greater than Residual Contaminant Levels (RCLs)**

**Table 2 - Groundwater Monitoring Analytical Results**

Well	MW-1	MW-2	MW-3	MW-105	PZ-101	PZ-102	MUN-1	MUN-2		
Date	10/9/2008	10/9/2008	10/9/2008	10/9/2008	10/9/2008	10/9/2008	10/9/2008	10/9/2008		
PVOOC(s), Naphthalene and Detected VOC(s) (ug/L)									PAL	ES
Benzene	<0.16	<0.16	<0.16	<0.16	<0.16	<0.16	<0.16	<0.16	0.5	5
Chloromethane	<0.30	<b>0.35</b>	<b>0.53</b>	<b>1.8</b>	<b>0.81</b>	<b>1.9</b>	<b>0.7</b>	<b>1.9</b>	0.3	3
1,1-Dichloroethene	<0.40	<0.40	<0.40	0.77	<0.40	<0.40	<0.40	<0.40	NA	NA
Ethylbenzene	<0.28	<0.28	<0.28	<0.28	<0.28	<0.28	<0.28	<0.28	140	700
Naphthalene	<0.60	<0.60	<0.60	<0.60	<0.60	<0.60	<0.60	<0.60	10	100
Toluene	<0.20	<0.20	<0.20	<0.20	<0.20	<0.20	<0.20	<0.20	200	1000
1,1,1-Trichloroethane	13	2.7	28	<b>58</b>	<0.50	<0.60	<0.60	<0.60	40	200
1,2,4-Trimethylbenzene	<0.24	<0.24	<0.24	<0.24	<0.24	<0.24	<0.24	0.54	96	480
1,3,5-Trimethylbenzene	<0.19	<0.19	<0.19	<0.19	<0.19	<0.19	<0.19	<0.19		
Xylenes	<0.50	<0.50	<0.50	<0.50	<0.50	<0.50	<0.50	<0.50	1000	10000

**Concentrations greater than the Preventative Action Limit (PAL)**

**Concentrations greater than the Enforcment Standards**